
CONVERSION FROM WAREHOUSE INTO VEHICLE STORAGE

NOTES 1. ALL WINDOWS WITHIN 18 INCHES OF THE FLOOR AND WITHIN 12 INCHES OF ANY DOOR ARE TO BE GLAZED WITH TEMPERED GLASS. 2. ALL TUB AND SHOWER ENCLOSURES ARE TO BE GLAZED WITH TEMPERED GLASS. . ALL SKYLIGHTS ARE TO BE GLAZED WITH SAFETY TEMPERED GLASS WITH A WIRE BURGLAR SCREEN INSIDE. 4. ALL INTERIOR FINISHES TO BE A MINIMUM OF CLASS 1 (0 TO 25 F.S.R.). PROVIDE A HARDWIRED SMOKE DETECTOR WITHIN 15 FEET OF EVERY BEDROOM AND AT THE TOP OF EVERY STAIR AT EACH LEVEL. . PROVIDE A HARDWIRED CARBON MONOXIDE DETECTOR WITHIN 40 FEET OF EVERY BEDROOM, AT LEAT ONE ON EACH LEVEL, AND ONE IN THE ROOM CONTAINING THE CENTRAL HEATING UNIT. . NO OPEN CUT OF VILLAGE STREETS ALLOWED & NO NEW SANITARY SERVICE B. NO CONCENTRATED DISCHARGE OF STORM WATER TO ADJACENT PROPERTIES SHALL BE ALLOWED. 9. PROVIDE FIRESTOPPING AT FOLLOWING LOCATIONS A) IN CONCEALED SPACES OF STUD WALLS AND PARTITIONS, INCLUDING FURRED SPACES, AT THE CEILING AND FLOOR B) AT ALL INTERCONNECTIONS BETWEEN CONCEALED VERTICAL AND HORIZONTAL SPACES SUCH AS AT SOFFITS, DROP CEILINGS, COVE CEILINGS, ETC; C) IN CONCEALED SPACES BETWEEN STAIR STRINGERS AT THE TOP AND BOTTOM OF THE RUN; D) AT OPENINGS AROUND VENTS, PIPES, DUCTS, CHIMNEYS AND FIREPLACES AT CEILING AND FLOOR LEVEL. E) BETWEEN STUDS AT 6'-0" HEIGHT MAX. EXCEPT AS OTHERWISE NOTED, IN OPENINGS IN MASONRY WALLS, PROVIDE A STEEL ANGLE FOR EACH 4" OF NOMINAL THICKNESS OF MASONRY IN ACCORDANCE WITH THE FOLLOWING SCHEDULE: $L1 - L \ 3 \ 1/2 \times 3 \ 1/2 \times 1/2$ UP TO 4'-6" $L2 - L 5 \times 3 1/2 \times 5/8$ UP TO 5'-6" UP TO 6'-6" L4 - W 8-21 UP TO 8'-6" ALL STEEL LINTELS SHALL BE 8" LONGER THAN THE CLEAR OPENING AT EACH END, AND MUST BEAR ON SOLID MASONRY (FILL CORES OR FROGS WITH NON-SHRINK GROUT). ANGLES MUST BE PLACED WITH THE LONGER LEG VERTICAL UNLESS NOTED OTHERWISE. MASONRY CONSTRUCTION MUST CONFORM TO ACI 530-95. . ALL HOLLOW MASONRY UNITS SHALL BE ASTM C90 NORMAL WEIGHT, TYPE 1. 3. JOINT REINFORCEMENT FOR SINGLE WYTHE WALLS MUST BE DURO-WALL TRUSS TYPE, HOT DIPPED GALVANIZED AFTER FABRICATION. THICKNESS OF SIDE RODS SHALL BE A MINIMUM OF 3/16 INCH THICK; CROSS TIES, A MINIMUM 9 GAUGE THICK. 4. PREFORMED CONTROL JOINTS MUST BE RUBBER MATERIAL ASTM D2240 WIDE FLANGE "RAPID CONTROL JOINT" AS MANUFACTURED BY DURO-WALL. 5. JOINT FILLER MUST BE EXPANDED CLOSED CELL NEOPRENE, WIDTH AND LENGTHS. . MORTAR MUST BE TYPE S, 1800psi CONFORMING TO ASTM C476 USING THE PROPORTION METHOD. . GROUT MIX MUST ACHIEVE 3,000 PSI AT 28 DAYS. SLUMP MUST BE 7-8 INCHES IN ACCORDANCE WITH ASTM C476. 8. DEFORMED VERTICAL REINFORCING STEEL IN WALLS, WHERE REQUIRED, MUST CONFORM TO ASTM A615, NEW BILLET STEEL GRADE 60. SEE DRAWINGS FOR 9. LAY MASONRY UNITS IN RUNNING BOND WITH CONCAVE MORTAR JOINTS. ONE MASONRY JOINT WITH ONE UNIT MASONRY SHALL BE 8 INCHES IN HEIGHT 10. INSTALL ALL REINFORCING IN WALLS WHERE INDICATED ON DRAWINGS. PLACE CONTROL JOINTS WHERE INDICATED ON DRAWINGS. WHERE CONTROL JOINTS ARE NOT INDICATED IN WALLS, SPACING SHALL NOT EXCEED 30 FEET ON CENTER. 11. SET LOOSE LINTELS WHERE INDICATED ON DRAWINGS. AT EACH LINTEL BEARING PLACE MINIMUM TWO COURSES FILLED SOLID WITH GROUT OR SOLID MASONRY UNITS UNDER EACH LINTEL BEARING POINT, UNLESS NOTED OTHERWISE. . ALL CONCRETE WORK MUST CONFORM TO ACI 318, STANDARD BUILDING CODE REQUIREMENTS FOR STRUCTURAL CONCRETE, LATEST EDITION. . CONCRETE MUST HAVE A STRENGTH OF F'C =3,500psi AT 28 DAYS. AT THE DISCRETION OF THE CONTRACTOR, HIGH EARLY STRENGTH CONCRETE MAY BE SUBSTITUTED. IF HIGH EARLY STRENGTH CONCRETÉ IS USED IT MUST ATTAIN A MINIMUM STRENGTH OF 3,500psi ÁT 7 DAYS. . CONCRETE MUST BE VIBRATED IMMEDIATELY AFTER PLACING. DO NOT USE CHLORIDE ADDITIVES. 4. CONCRETE EXPOSED TO WEATHER OR POURED AGAINST THE GROUND MUST HAVE 6% AIR ENTRAINMENT. FOOTINGS ARE DESIGNED FOR 3000psf SOIL BEARING CAPACITY. . MINIMUM COVER OF REINFORCEMENT IN FOUNDATION CONCRETE OR CONCRETE CAST AGAINST EARTH MUST BE 3 INCHES. CONCRETE MUST HAVE MINIMUM COVER OF 2 INCHES IN OTHER LOCATIONS, IF NOT SHOWN OTHERWISE. FORMS MAY BE RE-USED AS OFTEN AS PRACTICABLE. 8. DO NOT PLACE CONCRETE UNTIL ALL CONDUITS, PIPING OR OTHER EMBEDMENTS HAVE BEEN PLACED. 9. MECHANICAL PIPING UNDER SLABS MUST BE ENCASED BY A MINIMUM OF 6 INCHES OF CONCRETE. I. ROOF: SNOW LOAD=30PSF, DEAD LOAD=20PSF, WIND UPLIFT LOAD= 30PSF TOTAL LOAD=50PSF AND/OR PORCH 2. STAIRWAY & BALCONY RAILINGS (EXTERIOR & INTERIOR) MUST BE DESIGNED TO RESIST A SIMULTANEOUS VERTICAL AND HORIZONTAL THRUST OF 50PLF AND A 200 PLF LOAD AT ANY LOCATION ALONG THE RAIL. PORCH, DECK AND BALCONY LIVE LOAD 100 PSF, DEAD LOAD 10 PSF 4. FLOOR: LIVE LOAD=40PSF, DEAD LOAD=10PSF -- TOTAL LOAD=50PSF. . LUMBER: DOUGLAS LARCH No1 or BETTER Fb=1000psi Fc=625psi Ft=675psi Fc=1450psi Fv=180psi S. SOIL BEARING: MINIMUM 3,000psf, CONCRETE: 3,500psi @ 28 DAYS . STEEL REINFORCING ROLL SECTIONS CONFORM TO A572, AND A36 8. ALL MANUFACTURED BEAMS TO BE MICROLAM 1.9 E 9. PARTITION LOAD 5LB PER L.F. CARPENTRY NOTES: . INSTALL DOUBLE JOISTS UNDER ALL PARALLEL PARITIONS AND UNDER ANY TUB OR WHIRLPOOL. TYPICAL DOOR OR WINDOW HEADER TO BE 2-2X8 UNLESS NOTED OTHERWISE. PROVIDE GALVANIZED SHEET METAL DRIP CAPS AT ALL EXTERIOR DOORS AND WINDOW OPENINGS. 4. INSTALL DOUBLE FRAMING AROUND ALL FLOOR OR ROOF OPENINGS OR AS INDICATED, INCLUDING STAIRS OPENINGS AND ACCESS PANELS 5. DO NOT CUT OR DRILL THROUGH THE BOTTOM THIRD OF ANY BEAM OR JOIST. 6. AN INSPECTION OF FLOOR JOISTS MUST BE CONDUCTED BEFORE COVERING WITH SHEATHING 10. EXPANSION JOINTS, WHERE SHOWN MUST BE FULL DEPTH THICKNESS OF CONCRETE. 11. CONCRETE FLOOR SLABS WILL BE BROOM FINISHED. 12. REINFORCING STEEL SHALL BE NEW BILLET STEEL CONFORMING TO ASTM A615 GRADE 60. 13. WELDED WIRE FABRIC (WWF) MUST CONFORM TO ASTM A185 GRADE 60 OR HIGHER. 14. EXCEPT FOR WWF, REINFORCING MUST NOT BE WELDED. 15. SUBMIT SHOP DRAWINGS FOR ALL REINFORCED CONCRETE WORK FOR REVIEW. 16. ALL PLACING AND DETAILING MUST CONFORM TO ACI MANUAL OF STANDARD PRACTICE FOR REINFORCEMENT 17. ALL CONCRETE MUST BE TESTED FOR COMPRESSION STRENGTH. STANDARD TEST SPECIMENS MUST BE PERFORMED BY AN INDEPENDENT CERTIFIED LABORATORY AND CONFORM TO ASTM C-31 AT NO ADDITIONAL COST TO OWNER. SUBMIT A COPY OF TEST REPORT TO THE OWNER AND THE ARCHITECT. 18. EACH SAMPLING MUST CONSIST OF A MINIMUM OF 2 (TWO) CYLINDERS PER OPERATION, OR WHENEVER A CHANGE OCCURS IN WATER-CEMENT RATIO OR NOTICE TO CONTRACTORS: 1. THE CONTRACT DOCUMENTS FOR THIS PROJECT INCLUDE AN OWNER-CONTRACTOR AGREEMENT (AN EXECUTED WRITTEN PROPOSAL PREPARED BY THE CONTRACTOR DESCRIBING THE WORK) AND THESE DRAWINGS PREPARED BY THE ARCHITECT. THE ARCHITECT IS PROVIDING A "PLANS ONLY" SERVICE. NO OTHER TYPE OF ARCHITECTURAL SERVICE IS INTENDED OR IMPLIED. THESE PLANS ARE ONLY TO BE USED BY COMPETENT CONTRACTORS LICENSED WITHIN THE <u>VILLAGE OF WESTERN SPRINGS</u>, AND KNOWLEDGEABLE IN THE BUILDING TRADES. 2. THE CONTRACTOR MUST FAMILIARIZE HIMSELF WITH THE PROJECT LOCATION AND EXISTING CONDITIONS. CONTRACTOR MUST CHECK AND VERIFY ALL DIMENSIONS AND WILL BE RESPONSIBLE FOR THEM. DISCREPANCY WITH PLANS & EXISTING CONDITIONS MUST BE REPORTED TO ARCHITECT BEFORE STARTING ANY WORK. NON-COMPLIANCE WITH THE ABOVE CONDITION DISQUALIFIES ANY CLAIMS FOR ADDITIONAL COMPENSATION. 3. ADMINISTRATION OF THE CONTRACT IS BY THE OWNER OR HIS REPRESENTATIVE. THE CONTRACTOR AND THE OWNER ARE SOLELY RESPONSIBLE FOR THE BUILDING CONSTRUCTION PROCESS AND JOBSITE SAFETY. 4. THE DRAWINGS INDICATE THE GENERAL SCOPE OF THE PROJECT AND THE ARCHITECTURAL DESIGN CONCEPT, INCLUDING THE DIMENSIONS OF THE BUILDING, THE MAJOR ARCHITECTURAL ELEMENTS, AND TYPES OF STRUCTURAL, MECHANICAL, PLUMBING AND ELECTRICAL SYSTEMS. 5. THE DRAWINGS DO NOT NECESSARILY INDICATE OR DESCRIBE ALL THE WORK REQUIRED FOR REALIZATION OF THE SCOPE OR INTENT OF THE PROJECT; NOR ALL THE REQUIREMENTS OF THE CONTRACT DOCUMENTS. BASED ON THE GENERAL SCOPE DESCRIBED IN THESE DRAWINGS, THE CONTRACTOR WILL FURNISH AND INSTALL ALL THE ITEMS REQUIRED FOR THE PROPER EXECUTION OF THE INTENDED SCOPE OF THIS PROJECT. 6. THE ARCHITECT'S DECISION AS TO WHAT IS INCLUDED IN THE SCOPE AND WHAT IS NOT WILL BE FINAL AND BINDING ON THE CONTRACTOR. 7. BY SUBMITTING A BID OR PRICE PROPOSAL THE CONTRACTOR CONCEDES THAT HE HAS EXAMINED AND UNDERSTANDS ALL THE CONTRACT DOCUMENTS 8. THE INTENTION OF CONTRACT DOCUMENTS IS TO PERFORM THE WORK REQUIRED TO ACHIEVE THE FINISHED PROJECT IN A FIRST CLASS MANNER, COMPLYING WITH APPLICABLE TRADE STANDARDS AND GUIDELINES. LOCAL, STATE AND NATIONAL CODES, AND OBSERVING OHSA RULES. 9. THE START OF WORK WILL BE CONSIDERED AFFIRMATION THAT THE CONTRACTOR IS FULLY INFORMED OF THE SCOPE OF WORK AND THE TIME, WORK, MATERIALS, EQUIPMENT, APPLIANCES AND SERVICES NECESSARY TO ACHIEVE THE SCOPE OF WORK. 5. THE CONTRACTOR MUST SUBMIT TO THE OWNER AND COPY TO THE ARCHITECT A CERTIFICATE OF INSURANCE WHICH NAMES THE FOLLOWING AS ADDITIONALLY INSURED FOR THIS PROJECT: ARCHITECT VILLAGE OF WESTERN SPRINGS GENERAL NOTES: . CONTRACTOR TO VERIFY ALL DIMENSIONS IN FIELD. NOTED DIMENSIONS TAKE PRECEDENCE OVER SCALE - DO NOT SCALE DRAWINGS. INTERIOR DIMENSIONS ARE TO THE FACE OF A WALL UNLESS NOTED OTHERWISE. 4. EXTERIOR DIMENSIONS ARE TO THE FACE OF MASONRY FOUNDATION WALLS. UPPER FLOORS ARE TO THE FACE OF SHEATHING, OR MASONRY IF USED. 5. EXTERIOR DIMENSIONS OF FRAME WALLS ARE TO FACE OF SHEATHING UNLESS NOTED OTHERWISE. 6. ALL MATERIALS AND EQUIPMENT MUST BE INSTALLED IN COMPLIANCE WITH THE MANUFACTURER'S INSTRUCTIONS AND RECOMMENDATIONS. 7. CONTRACTOR IS RESPONSIBLE FOR REMOVAL AND PROPER DISPOSAL OF ALL DEBRIS GENERATED BY THE WORK. CLEAN UP IS REQUIRED ON A DAILY BASIS. DISPOSE OF DEBRIS LEGALLY. 8. CONTRACTORS IS TO GUARANTEE ALL THE WORK, MATERIALS AND LABOR IN WRITING FOR A MINIMUM OF ONE (1) YEAR AGAINST ALL DEFECTS OF MATERIALS, EQUIPMENT AND WORKMANSHIP.

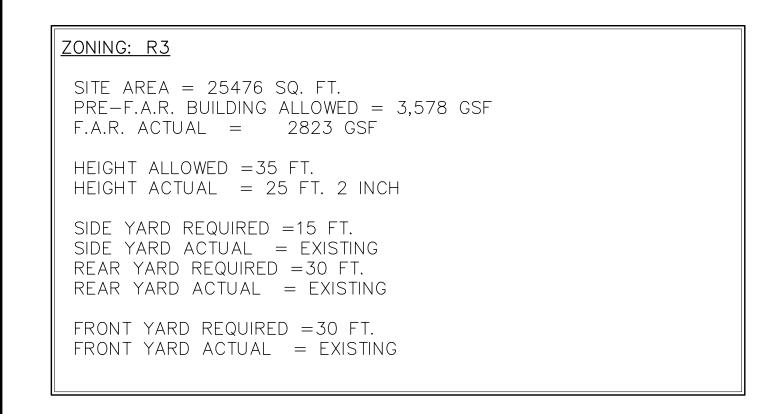

ASHPHALT:

BUILDING CODES WITH WESTERN SPRINGS AMENDMENTS:

International Building Code (IBC), 2006 Edition
International Energy Conservation Code (IECC), 2012 Edition
National Electrical Code (NEC-NFPA 70), 2005 Edition
International Property Maintenance Code (IPMC), 2006 Edition
International Fire Code (IFC), 2006 Edition
International Mechanical Code (IMC), 2006 Edition
International Fuel Gas Code (IFGC), 2006 Edition
Life Safety Code (NFPA-101), 2006 Edition
Illinois State Plumbing Code (ISPC), 2014 Edition
Illinois Accessibility Code (IAC), 1997 Edition
Village of Western Springs Building Regulations

EXISTING FENCE

268.16

CONCRETE

GARAGE



1428 HILLGROVE AVE. WESTERN SPRINGS, IL

SCOPE OF WORK:


CONVERSION FROM WAREHOUSE INTO VEHICLE STORAGE

1. THE WORK OF THIS PROJECT IS TO REMOVE WALLS.

2. INSTALL NEW PLUMBING FIXTURES, WITH NEW PLUMBING BRANCHES

3. INSTALL NEW ELECTRICAL SUPPLY SYSTEM

4. INSTALL NEW RADIANT FLOOR HEATING

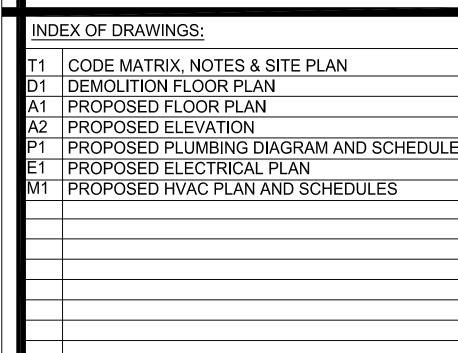

CERTIFICATION STATEMENT

I HEREBY CERTIFY THAT THESE PLANS WERE PREPARED UNDER MY DIRECT SUPERVISION AND TO THE BEST OF MY PROFESSIONAL KNOWLEDGE THEY CONFORM TO THE INTERNATIONAL BUILDING CODE(IBC), 2006 EDITIONAL BUILDING CODE(IBC), 2006 EDITIONAL FREDERICK

GNED Fredrillo

EXPIRATION DATE: 11-30-16

ENERGY CONSERVATION CODI

ENERGY CONSERVATION CODE COMPLIANCE STATEMENT

I CERTIFY THAT I AM A REGISTERED ENERGY PROFESSIONAL (REP)
I ALSO CERTIFY THAT TO THE BEST OF MY PROFESSIONAL
KNOWLEDGE AND BELIEF THAT THE PLANS FOR
1428 HILLGROVE AVE., WESTERN SPRINGS, IL

1428 HILLGROVE AVE., WESTERN SPRINGS, IL FULLY COMPLY WITH THE REQUIREMENTS OF INTERNATIONAL ENERGY CONSERVATION COLL AS EFFECTIVE 2012 EDITION

10

Jederi/log

EXPIRATION DATE: 11-30-16

929 N. Damen Ave. Chicago IL 60622 773 772 2756 office 773 772 2854 fax

FREDERICK

E. KOZIOL

001-010395

E. KOZIOL

001-010395



ARCHITECTURE
PLANNING
ARCHITECTURAL ENGINEERING

 REVISIONS:
 PROJECT:

 1428 HILLGROVE

 AVE.

 CHECKED BY:
 SCALE:

 F.E.K.
 ½6" = 1'-0"

 DRAWN BY:
 DATE:

09-21-2016


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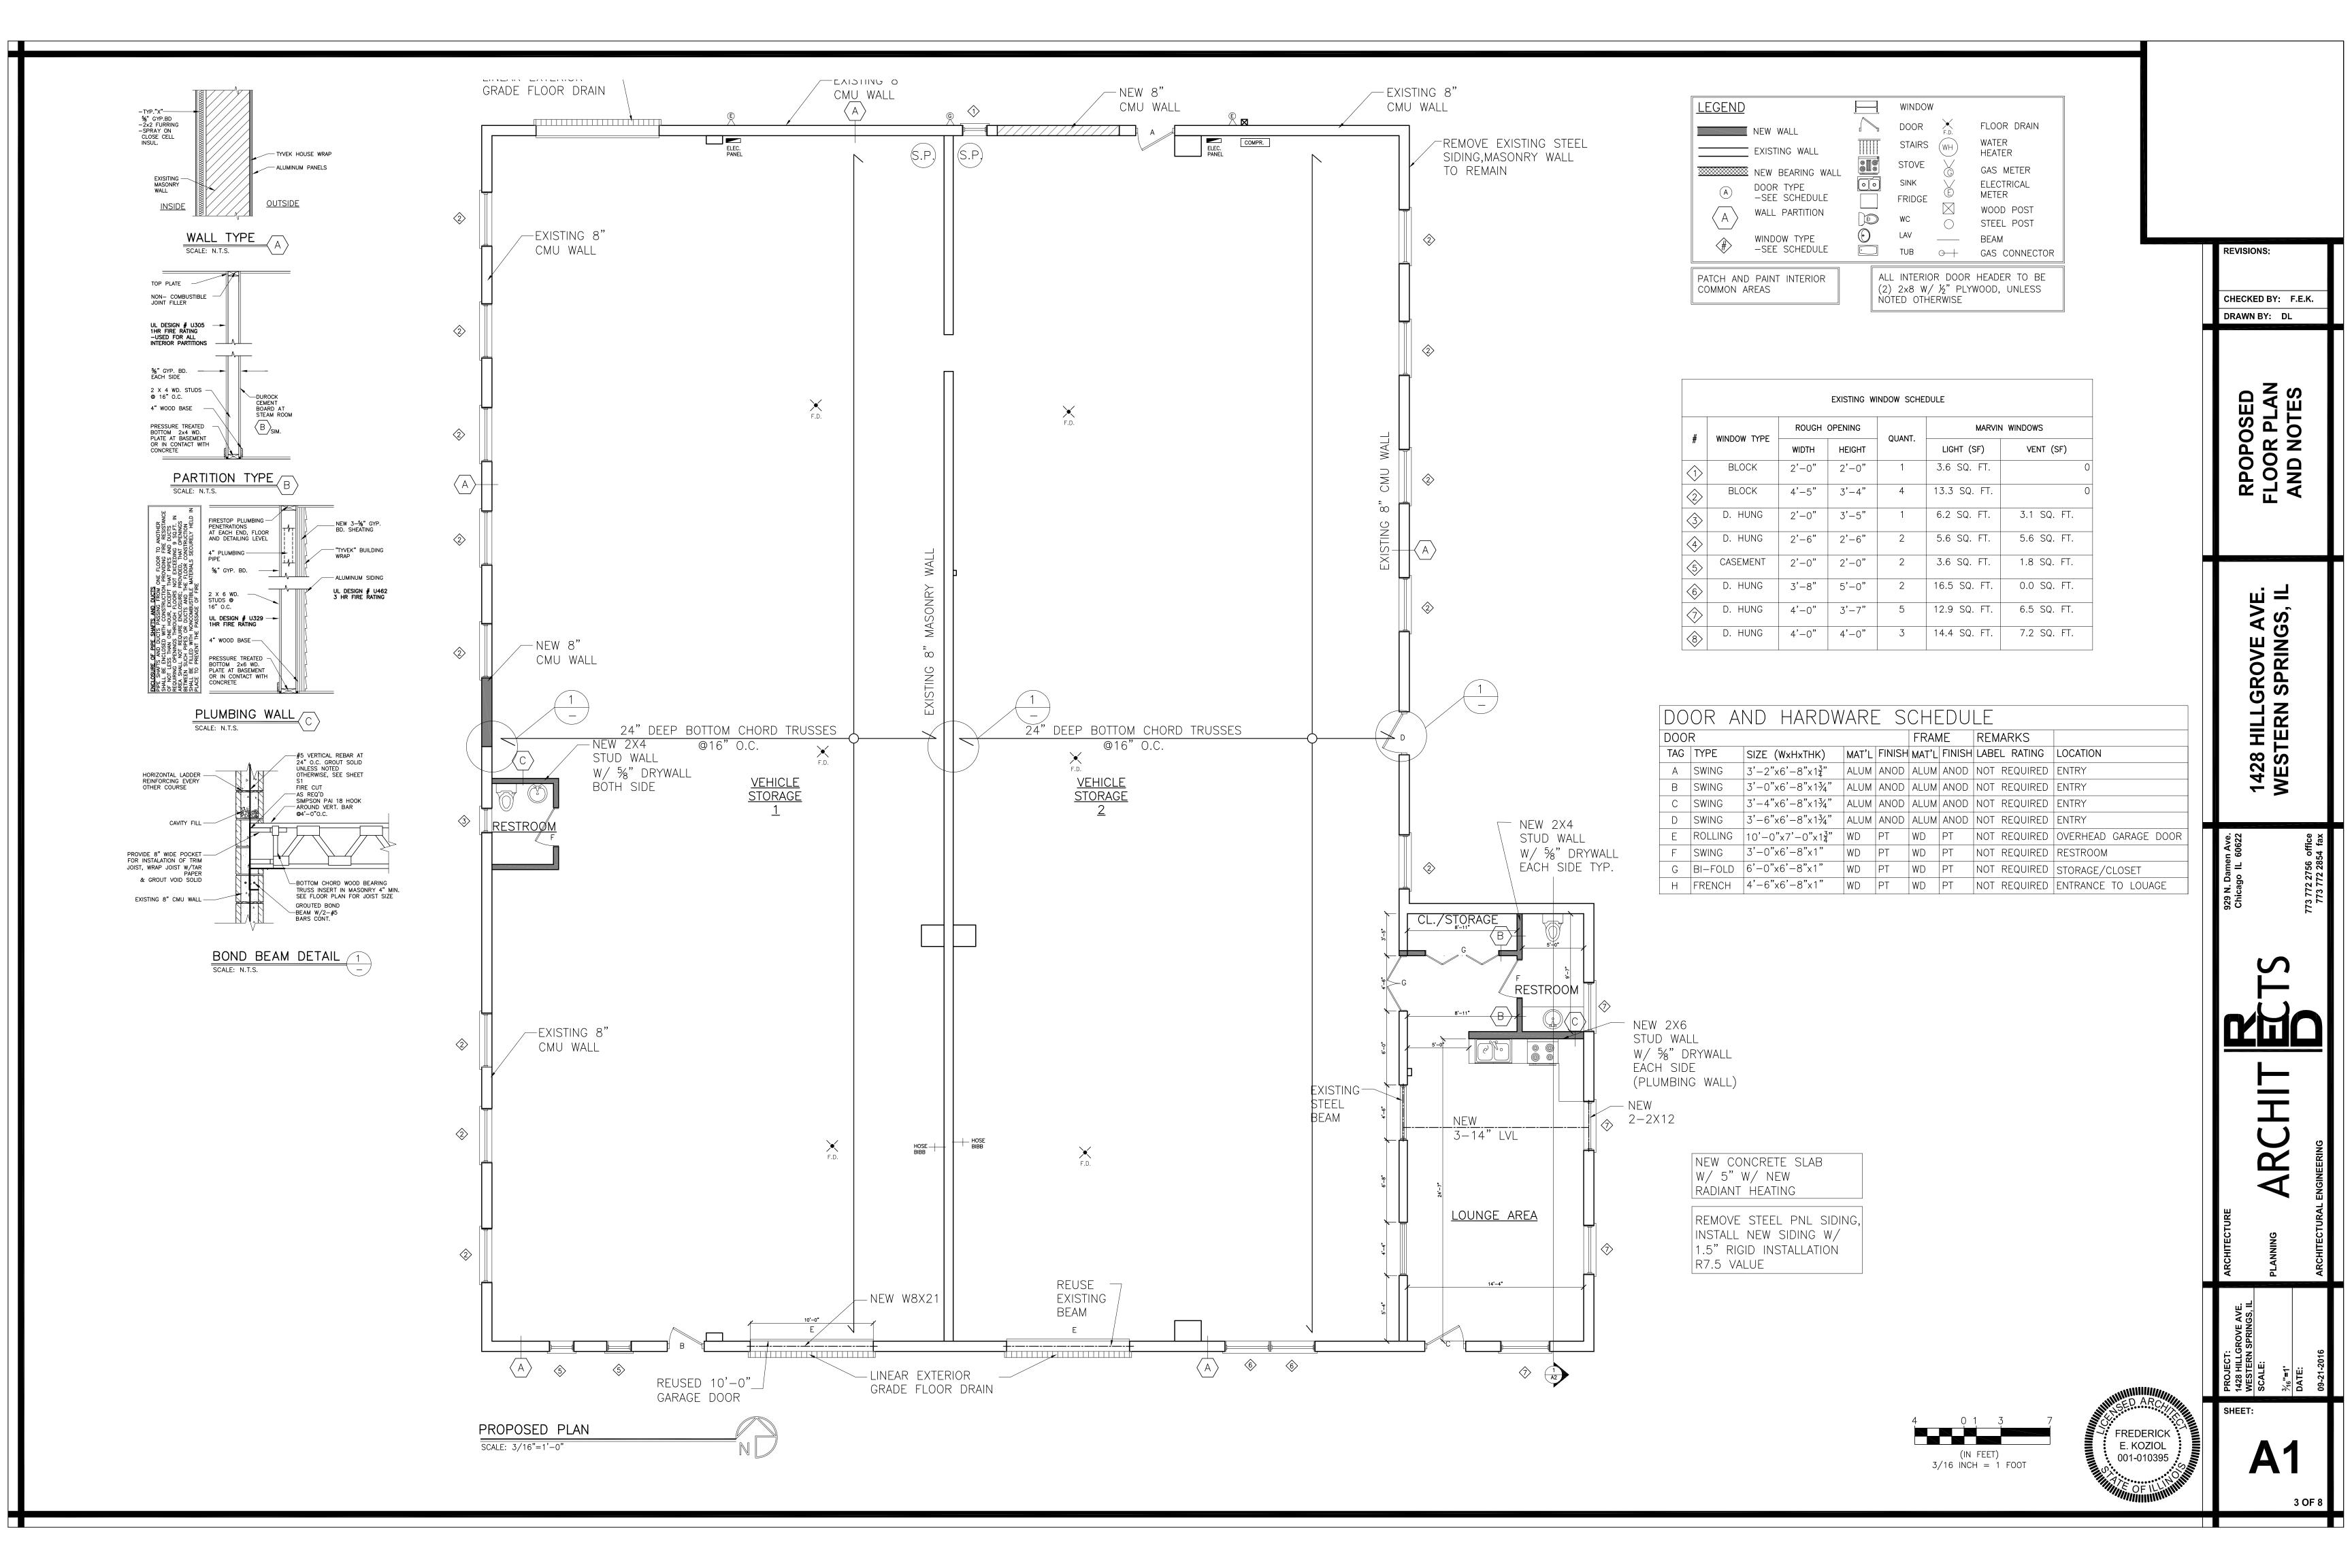
1/16 INCH = 1 FOOT


FREDERICK

E. KOZIOL

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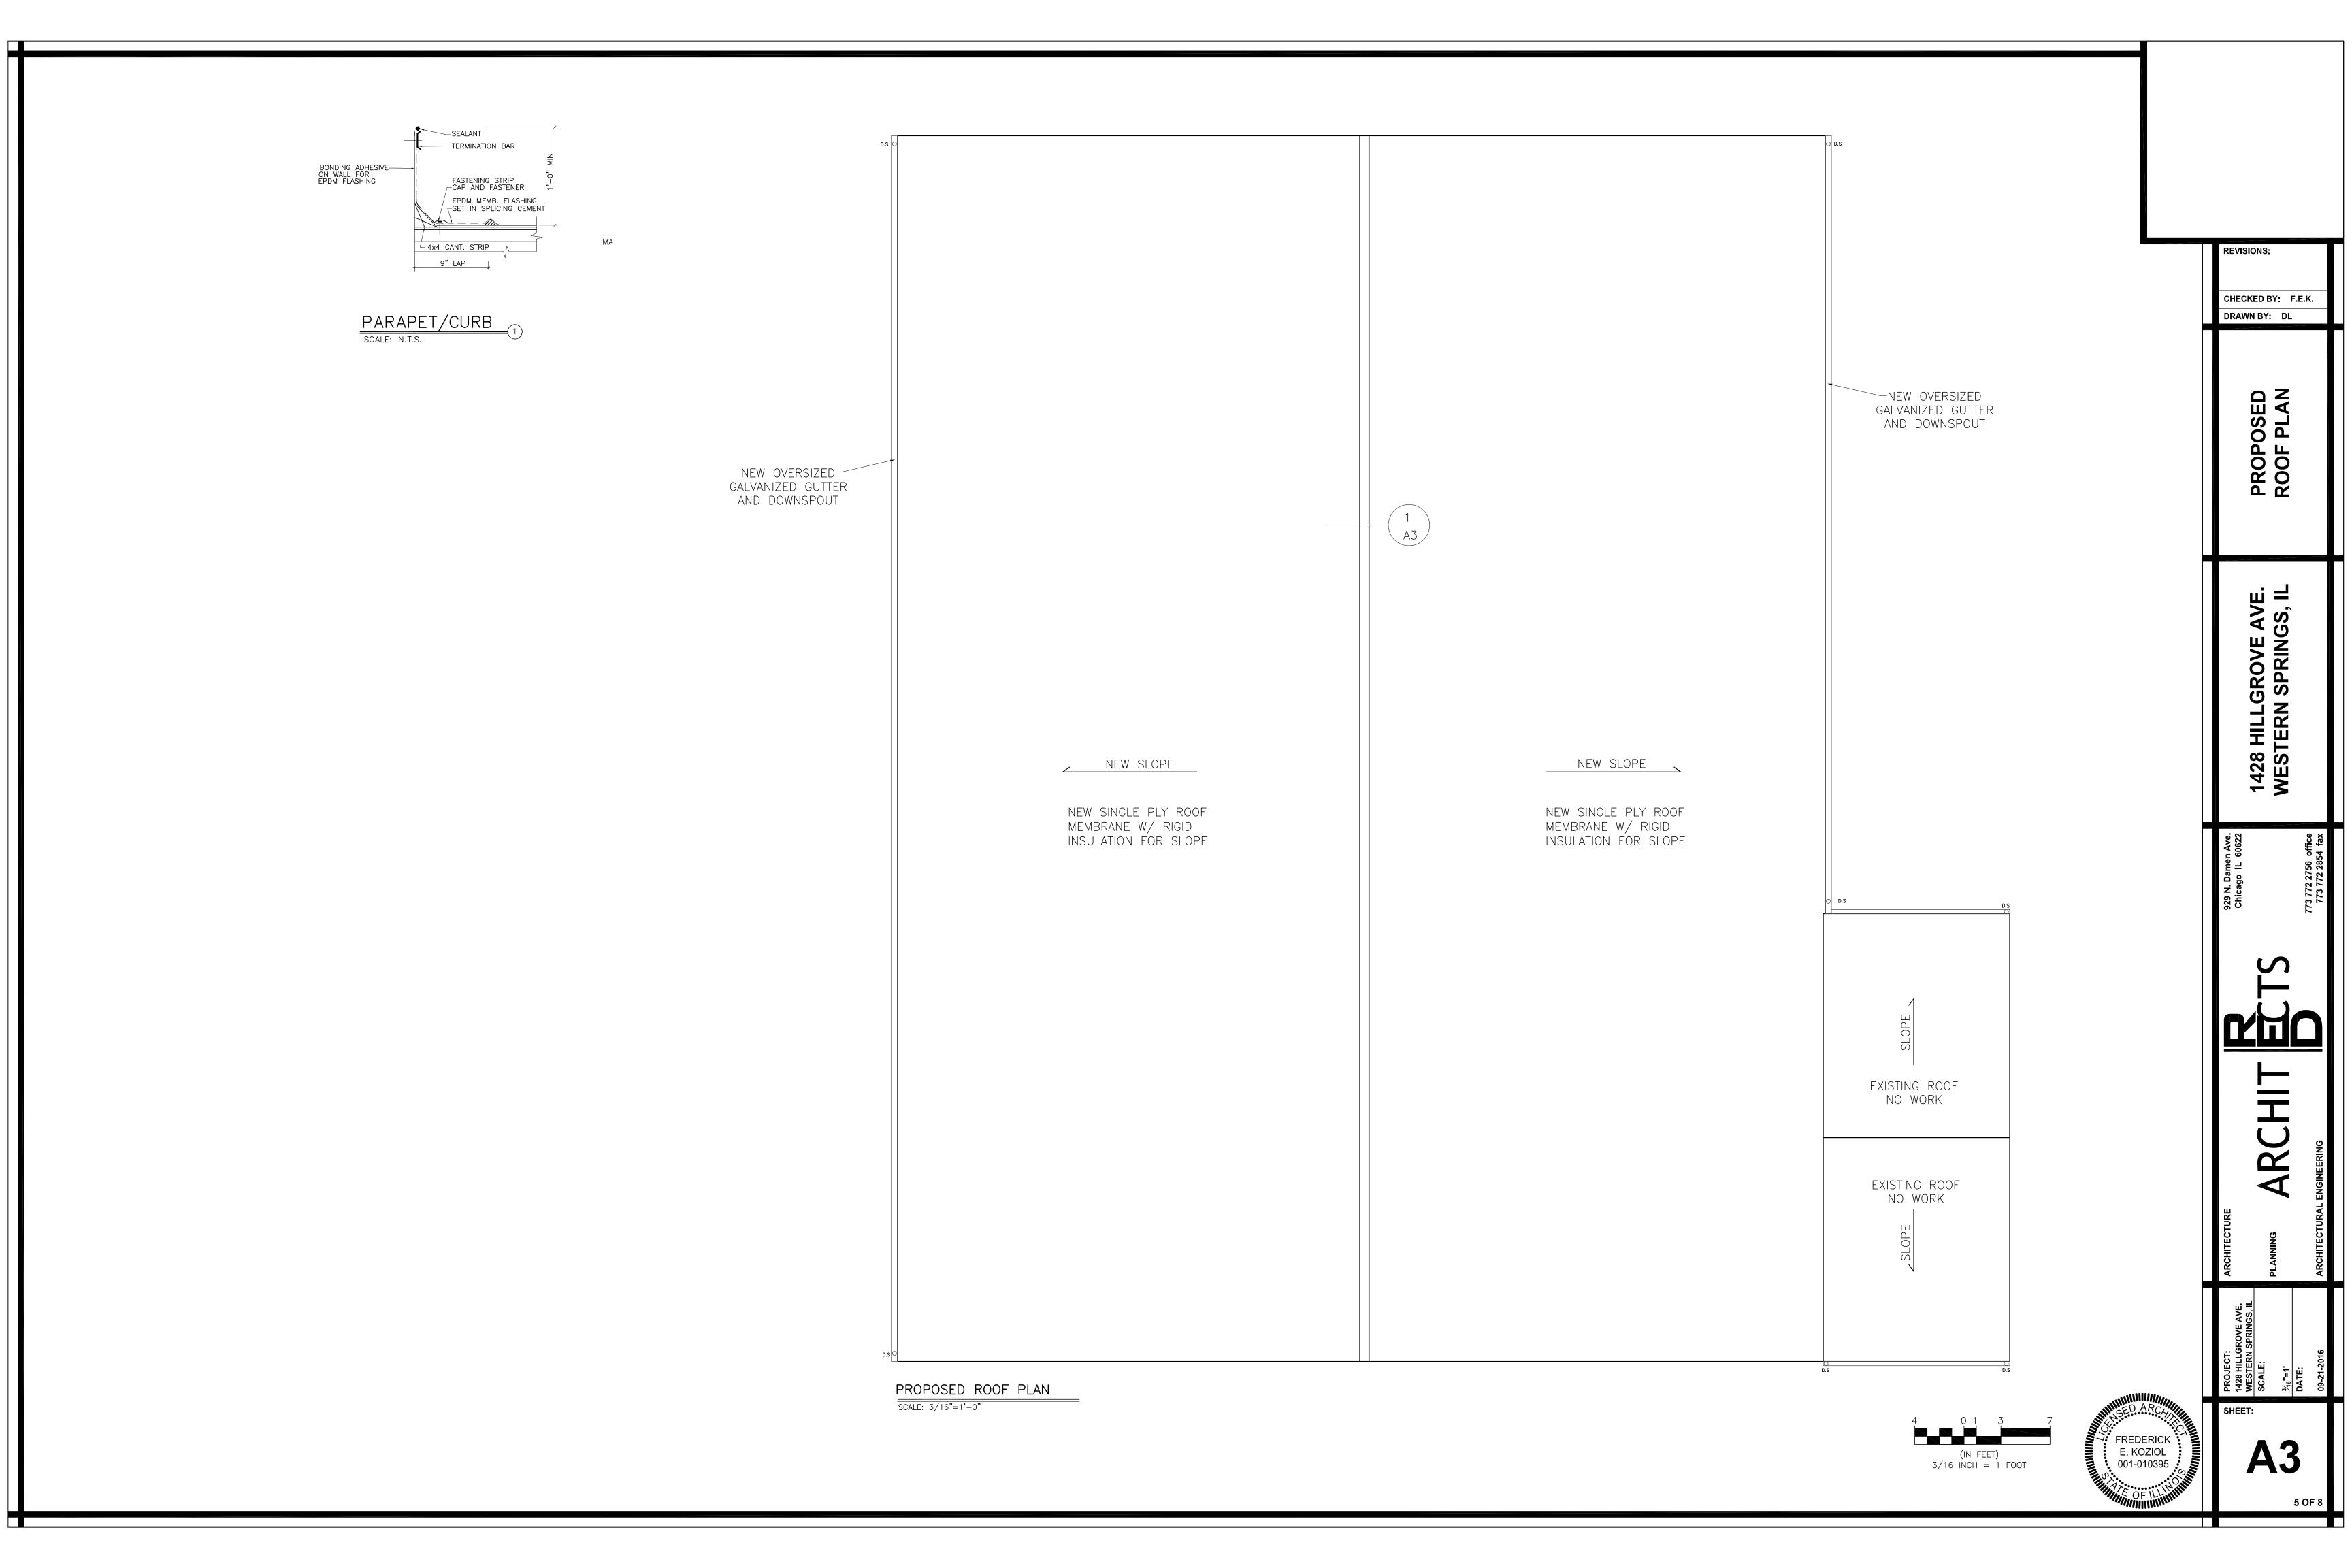




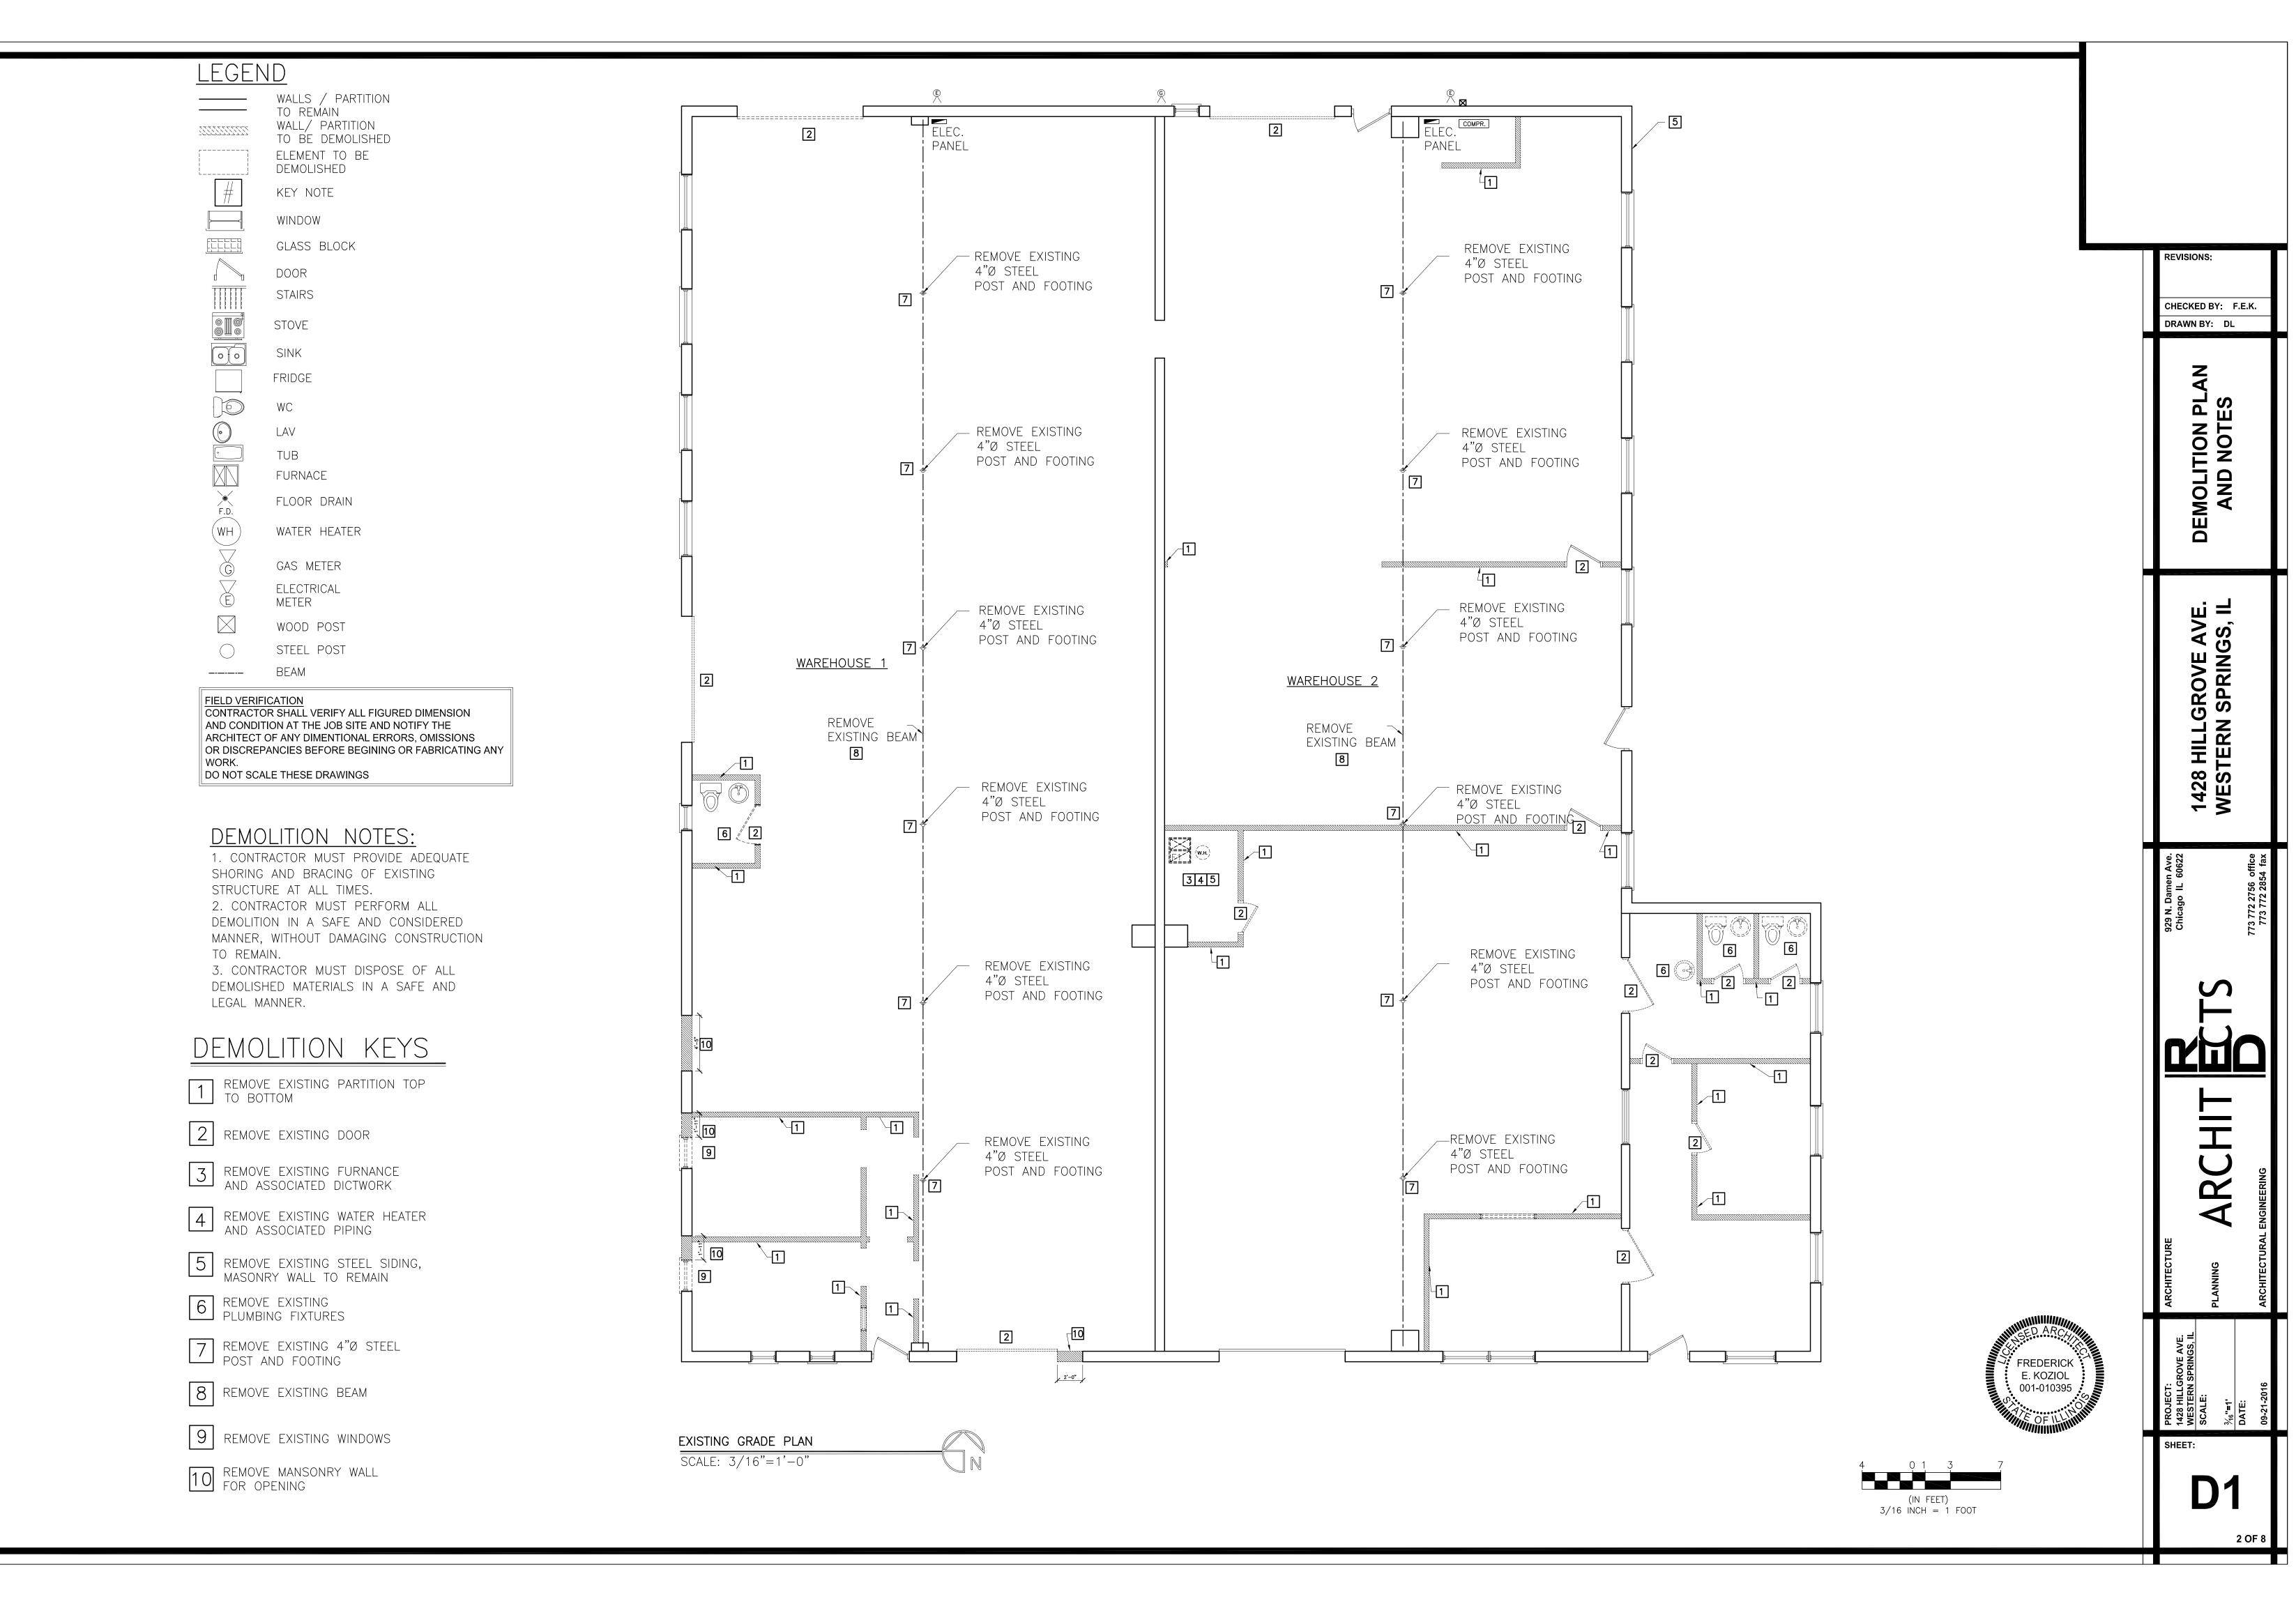

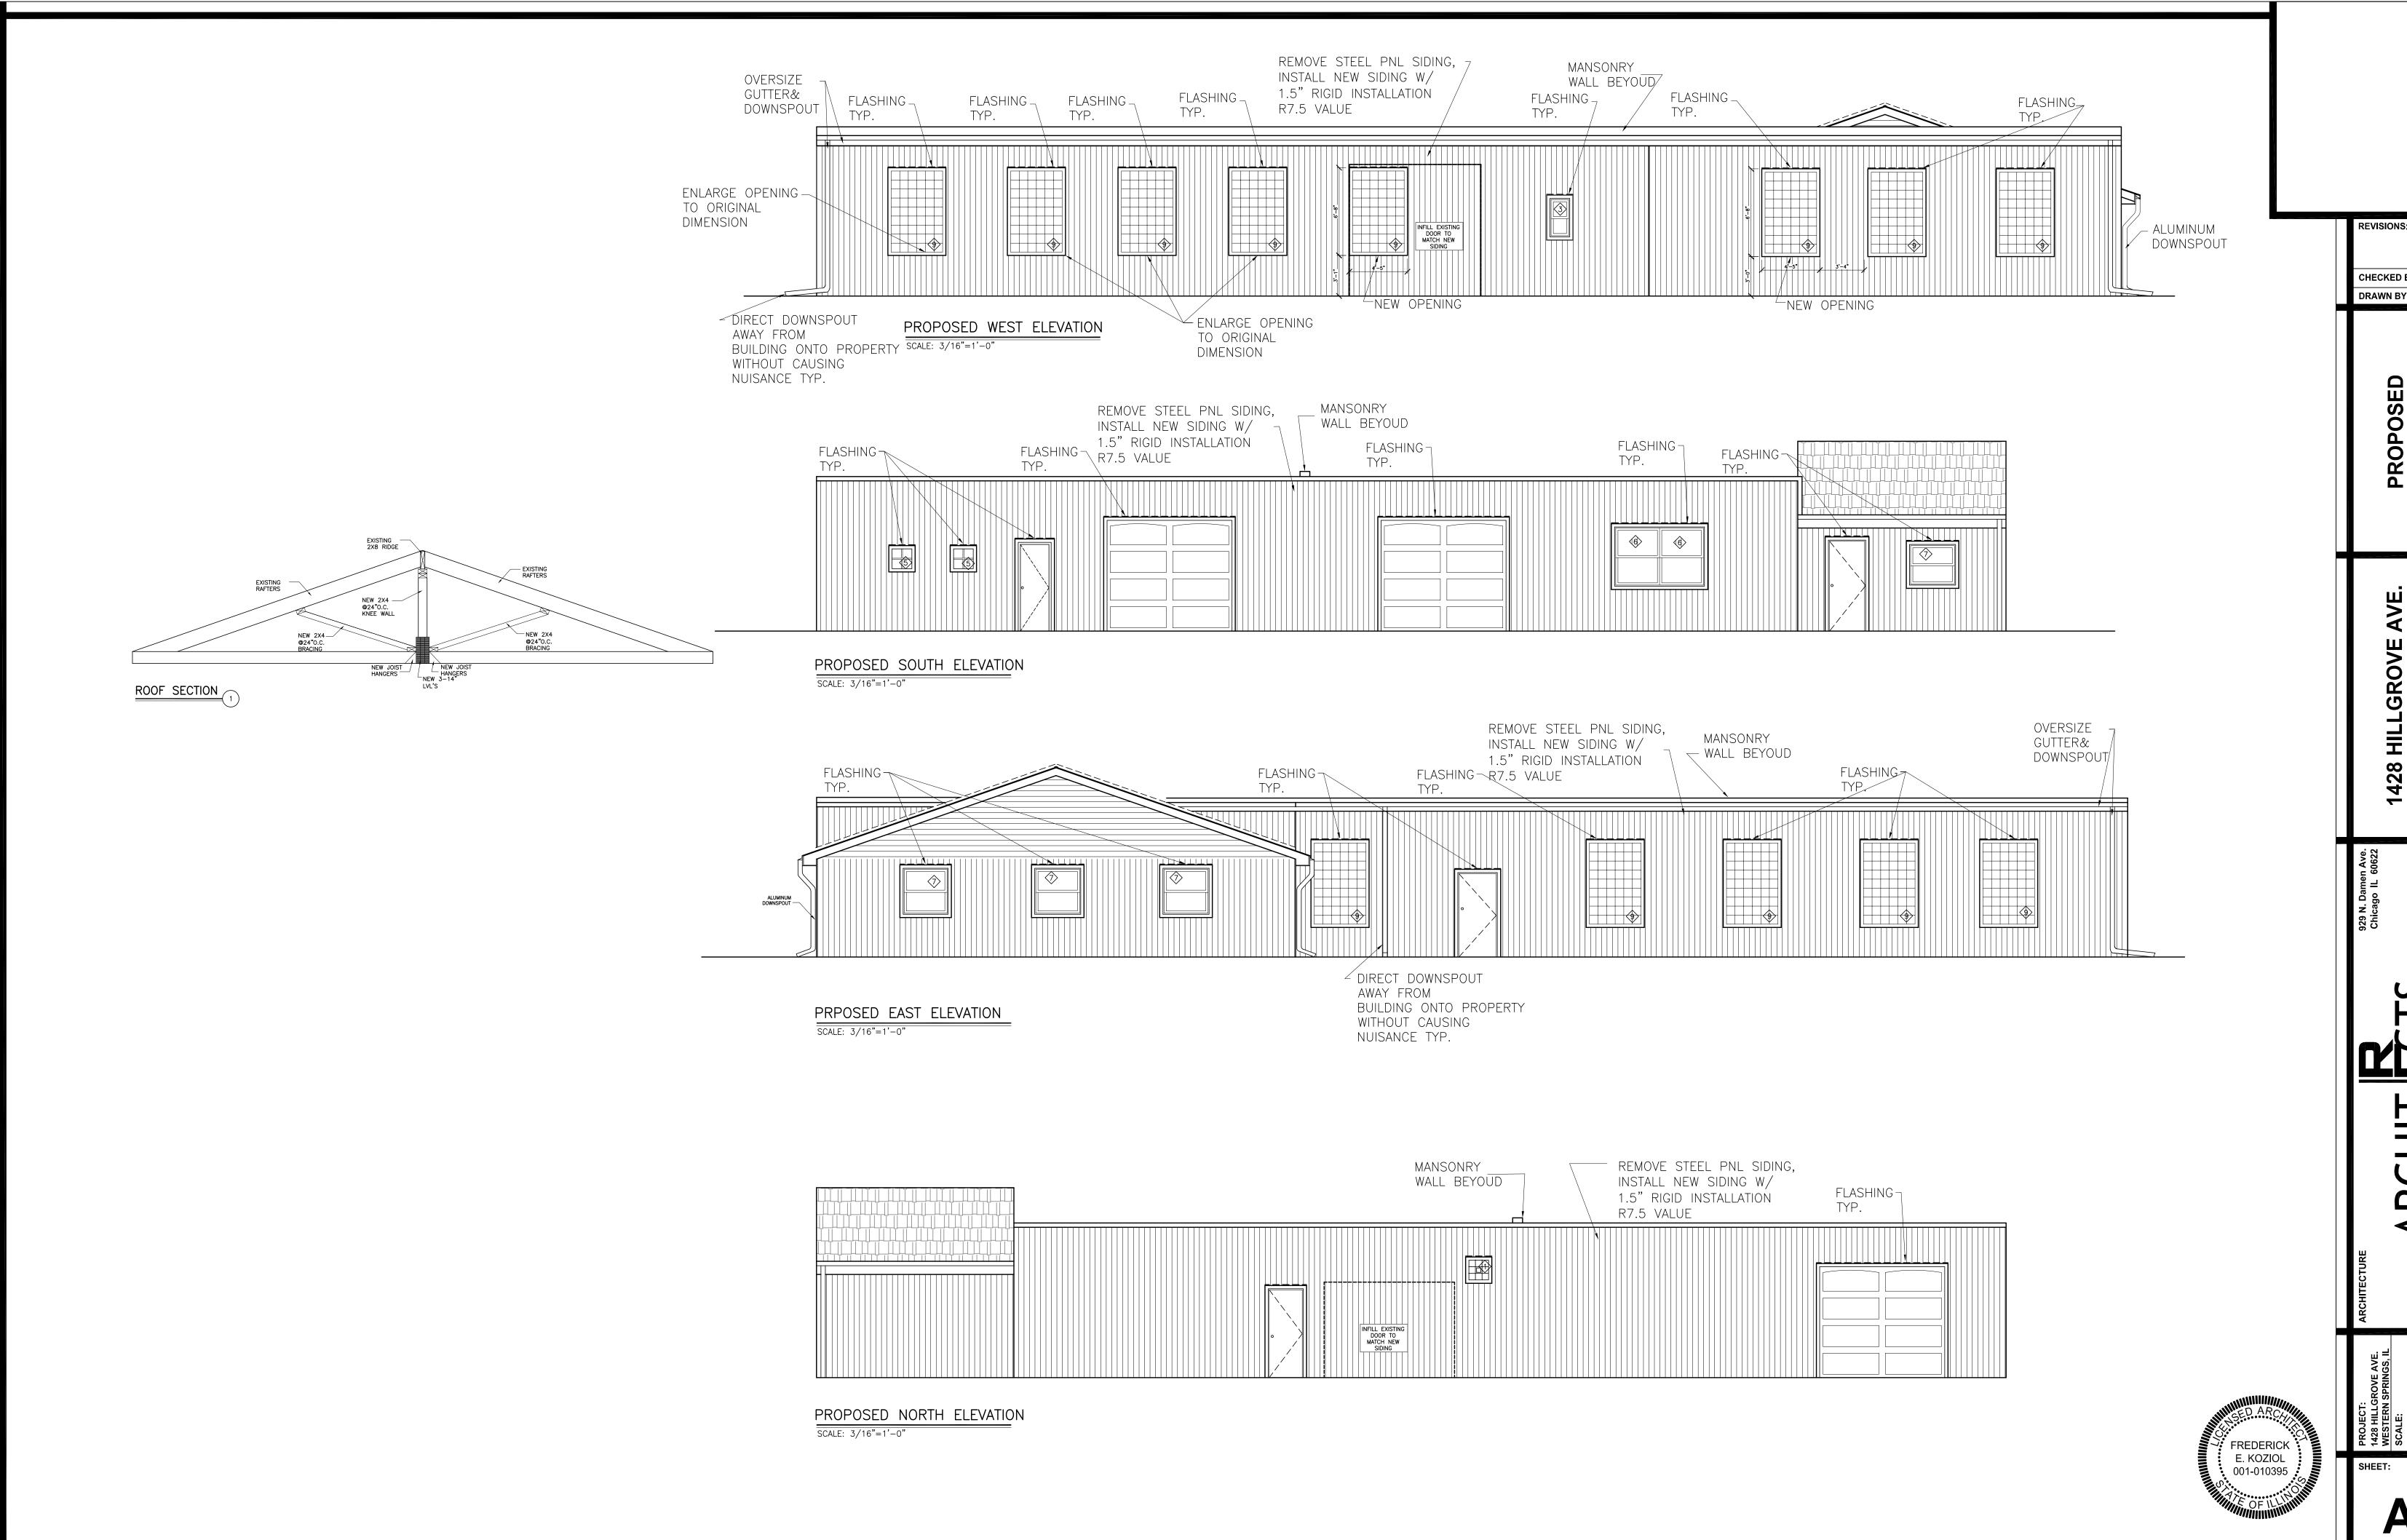REVISIONS: CHECKED BY: F.E.K. DRAWN BY: DL PROPOSED ELEVATIONS

1428 HILLGROVE AVE. WESTERN SPRINGS, IL



PLUMBING NOTES: 1. ALL PLUMBING WORK MUST BE PERFORMED BY LICENSED CONTRACTOR AS REQUIRED BY STATE OF ILLINOIS PLUMBING CODE(ISPC),2014 EDITION. 2. PLUMBING CONTRACTOR SHALL OBTAIN ALL REQUIRED BONDS AND PAY ALL FEES AND TAXES FOR NECESSARY PLUMBING PERMITS. 3. FURNISH AND INSTALL COMPLETE DRAIN AND SEWER SYSTEM. HOUSE SEWER AND DRAINPIPES BELOW GRADE SHALL BE CAST IRON SOIL PIPE. 4. FURNISH AND INSTALL SOIL, WASTE AND VENT PIPES AS REQUIRED. ALL ABOVE GROUND SOIL STACKS, WASTE STACKS, VENT PIPES AND FITTINGS TO BE CAST IRON OR PVC. 5. ALL TRAPS SHALL BE SELF-CLEANING. 6. FURNISH AND INSTALL COMPLETE AND OPERABLE SYSTEM OF DOMESTIC COLD AND HOT WATER TO EACH AND EVERY PLUMBING FIXTURE, APPLIANCE OR MECHANICAL EQUIPMENT REQUIRING WATER. INSTALL AS REQUIRED BY CODE PIPEFITTING, VALVES AIR CHAMBERS DI-ELECTRIC UNIONS HANGERS, ETC. INSTALL ALL PLUMBING FIXTURES, COMPLETE WITH TRAPS, STOPS, HANGERS AND ALL RELATED ITEMS AS REQUIRED. 7. INSULATE ALL HOT AND COLD WATER PIPING NOT IN PLUMBING CHASE WITH $\frac{1}{2}$ " FIBERGLASS INSULATION. ALL

PIPING IN EXTERIOR WALLS OR IN SUSPENDED, UNHEATED SPACES SHALL HAVE 3" MIN. THICK INSULATION. 8. DOMESTIC HOT AND COLD WATER PIPING ABOVE THE GRADE SHALL BE TYPE "K" COPPER. (TYPE "L" UNDERGROUND) INSTALL DI-ELECTRIC UNIONS AT DISSIMILAR MATERIALS. 9. PROVIDE: A. 24" AIR CHAMBER AT ALL RISER MAINS.

B. 12" AIR CHAMBER AT ALL PLUMBING FIXTURES. C. SHUT OFF VALVES AT ALL PLUMBING FIXTURES AND D. NON-FREEZE SILL COCKS - VACUUM BREAKER


TYPE 2. 10. ROOF VENTS SHALL EXTEND A MINIMUM OF 12" ABOVE

11. THE PLUMBER MUST TEST THE ENTIRE PLUMBING SYSTEM UNDER EITHER A WATER OR AIR PRESSURE

12. THE PLUMBING CONTRACTOR SHALL DISINFECT THE ENTIRE WATER SERVICE SUPPLY SYSTEM BEFORE SYSTEM OPERATION.

13. THE DRAIN AND SEWER SHALL BE ROOT PROOF AND WATER TIGHT AND TESTED WITH A MIN. TEN (10) FOOT WATER COLUMN.


14. FURNISH AND INSTALL GAS PIPING WITH SHUTOFF COCKS AT EACH AND EVERY APPLIANCE REQUIRING GAS. INCLUDING FURNACE, DOMESTIC WATER HEATERS, ETC. PIPING SHALL BE SCHEDULE 40 BLACK STEEL, "GRADE A" FITTINGS SHALL BE STANDARD WEIGHT, BLACK MALLEABLE IRON OR CAST IRON SCREENED AND RATED AT 150 PSI.

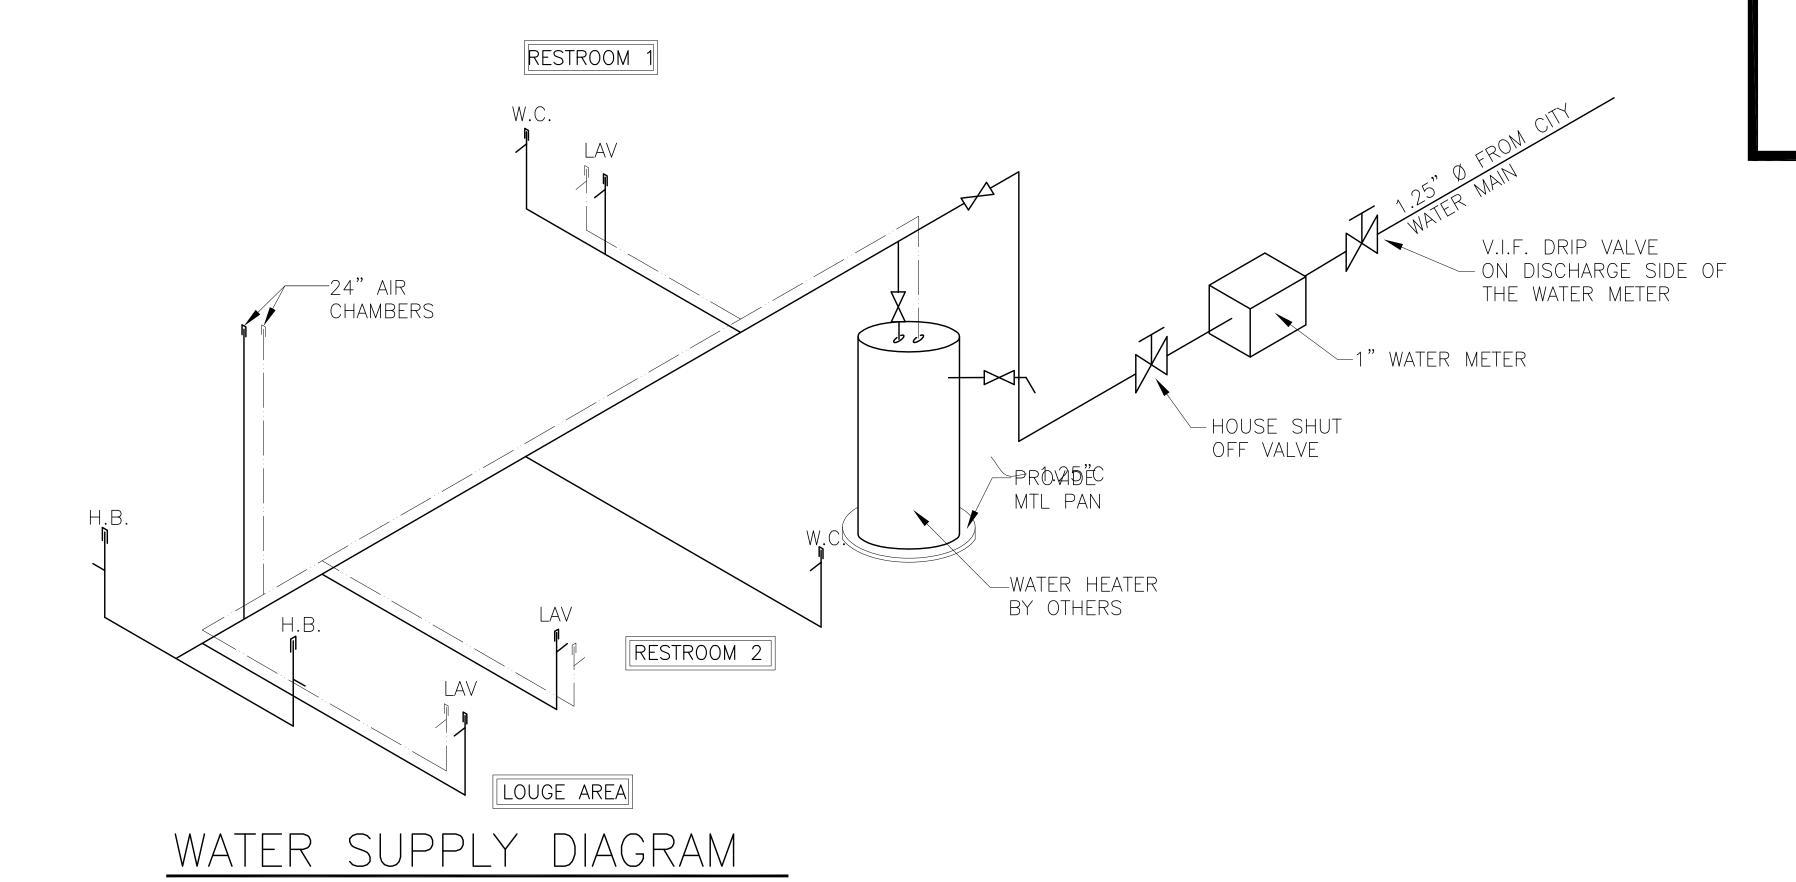

PLUMBING FIXTURE SCHEDULE			
WATER CLOSET	2	AMERICAN STANDARD <u>CERAMIC</u>	
LAVATORY	2	AMERICAN STANDARD <u>CERAMIC</u>	
H.B.	2	BRASS MPT x MHT <u>STEEL</u>	

SCALE: N.T.S.

*PROVIDE HOT WATER SUPPLY PIPE WITH CONSTRUCTED SWING JOINT

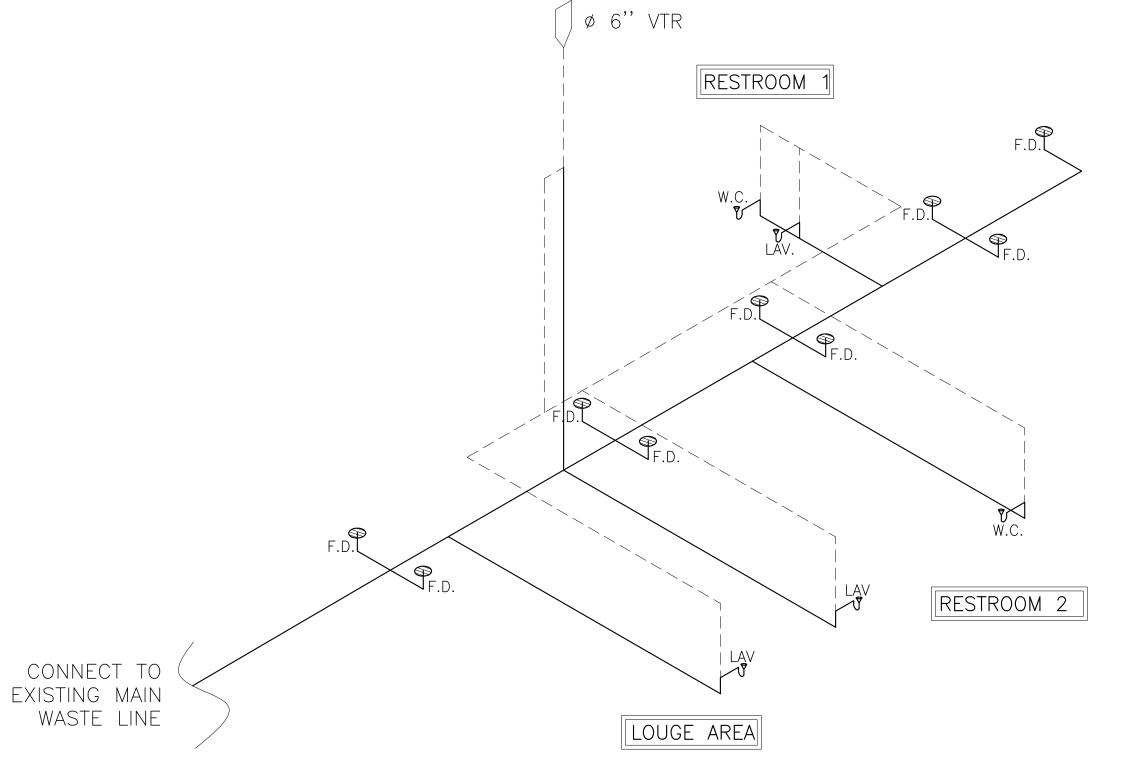

WASTE DIAGRAM SCALE: N.T.S.



REVISIONS:

DRAWN BY: DL

CHECKED BY: F.E.K.

PLUMBING SCHEDULES AND NOTES

1428 HILLGROVE AVE. WESTERN SPRINGS, IL

RCHIT

SHEET: P₁

